
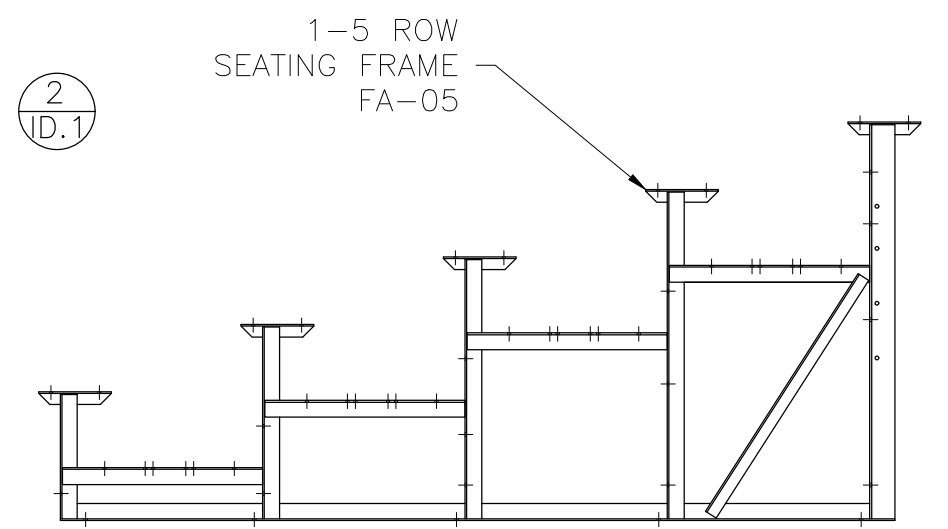
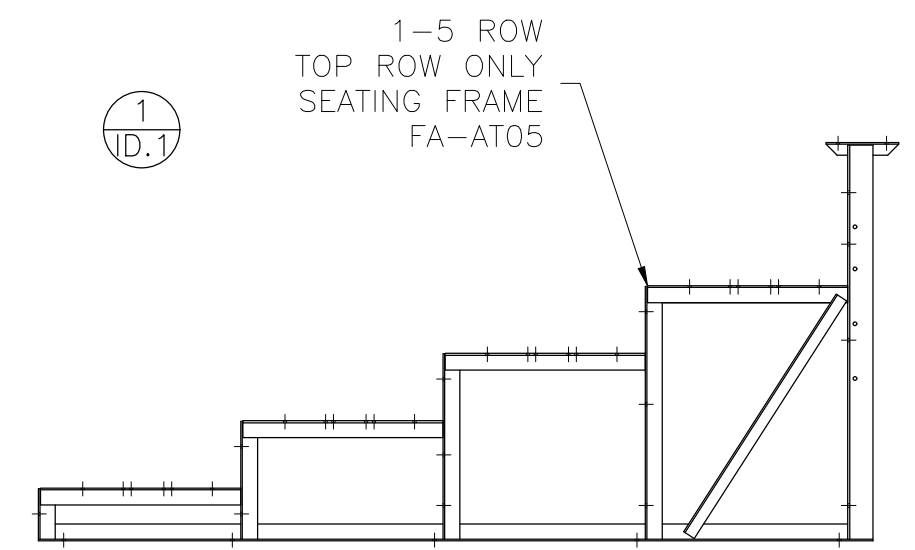


NA-0515DLX_CLL

NON ELEVATED 5 ROW x 15'-0" ALUMINUM BLEACHER

National Recreation Systems, Inc.

CS.1	- COVER SHEET
TD.1	- BLEACHER SEATING PLAN
FP.1	- FOUNDATION PLAN
AP.1	- ANCHORING PLAN
BA.1	- BLEACHER ASSEMBLY
BR.1	- BRACE ASSEMBLY
PF.1	- PLANK & FRAMING PLAN
VA.1	- VERTICAL AISLE ASSEMBLY
GR.1	- GUARDRAIL ASSEMBLY
DS.1	- DETAIL SHEET

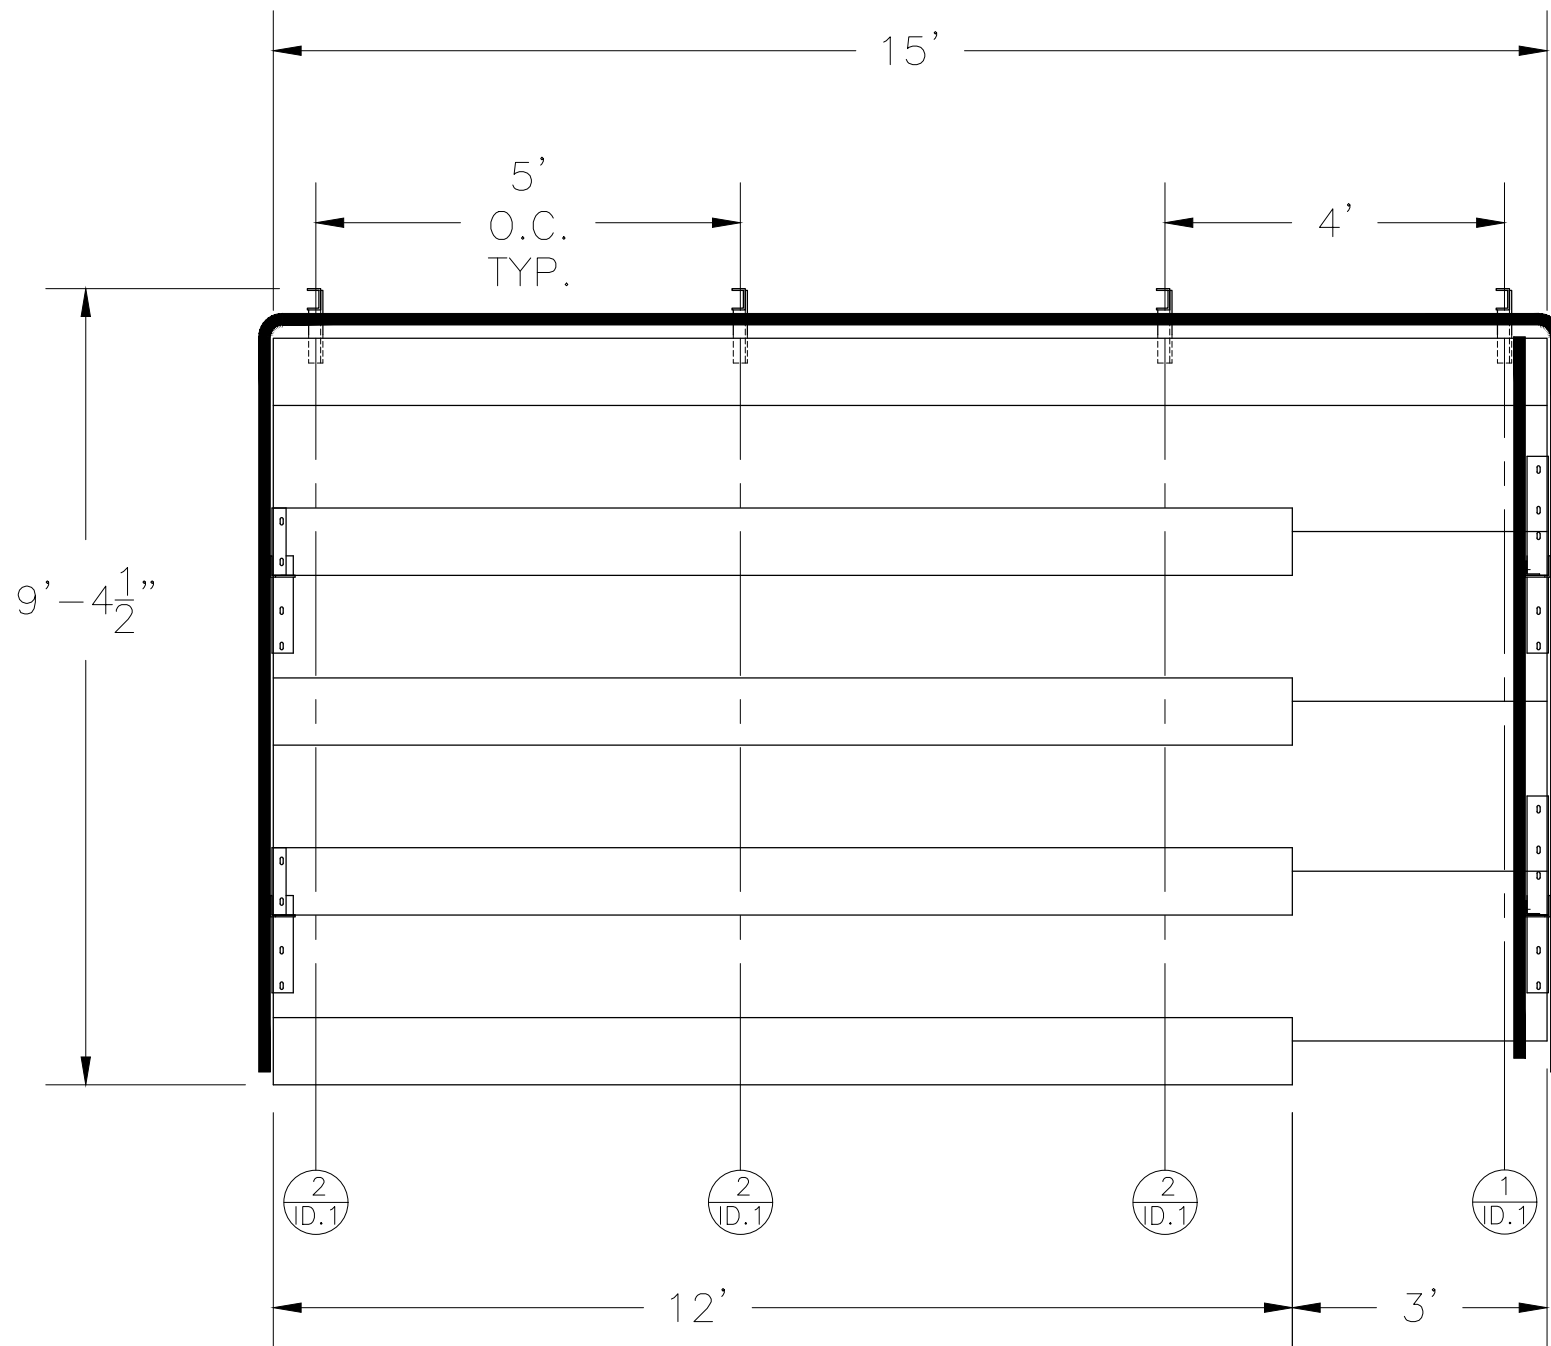


SECTION LENGTH	GROSS SEATS	ACTUAL SEATS	NO. OF ROWS	NET SEATS
15	10.00	10.00	1	10
12	8.00	8.00	4	32
			NET SEATS	42
			WHEELCHAIR SPACES	0
			TOTAL NET SEATING CAPACITY	42
			(BASED ON 18" PER SEAT)	

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National Recreation Systems, Inc.

SCALE: N.T.S.	APPROVED BY: CHUCK	DRAWN BY: JML
DATE: 10/02/2015	5/20/2016	
TITLE: NON ELEVATED 5 ROW x 15'-0" BLEACHER SEATING PLAN		
CUSTOMER: NA-0515DLX_CLL	DRAWING NUMBER:	REV. DATE: 010/02/2015

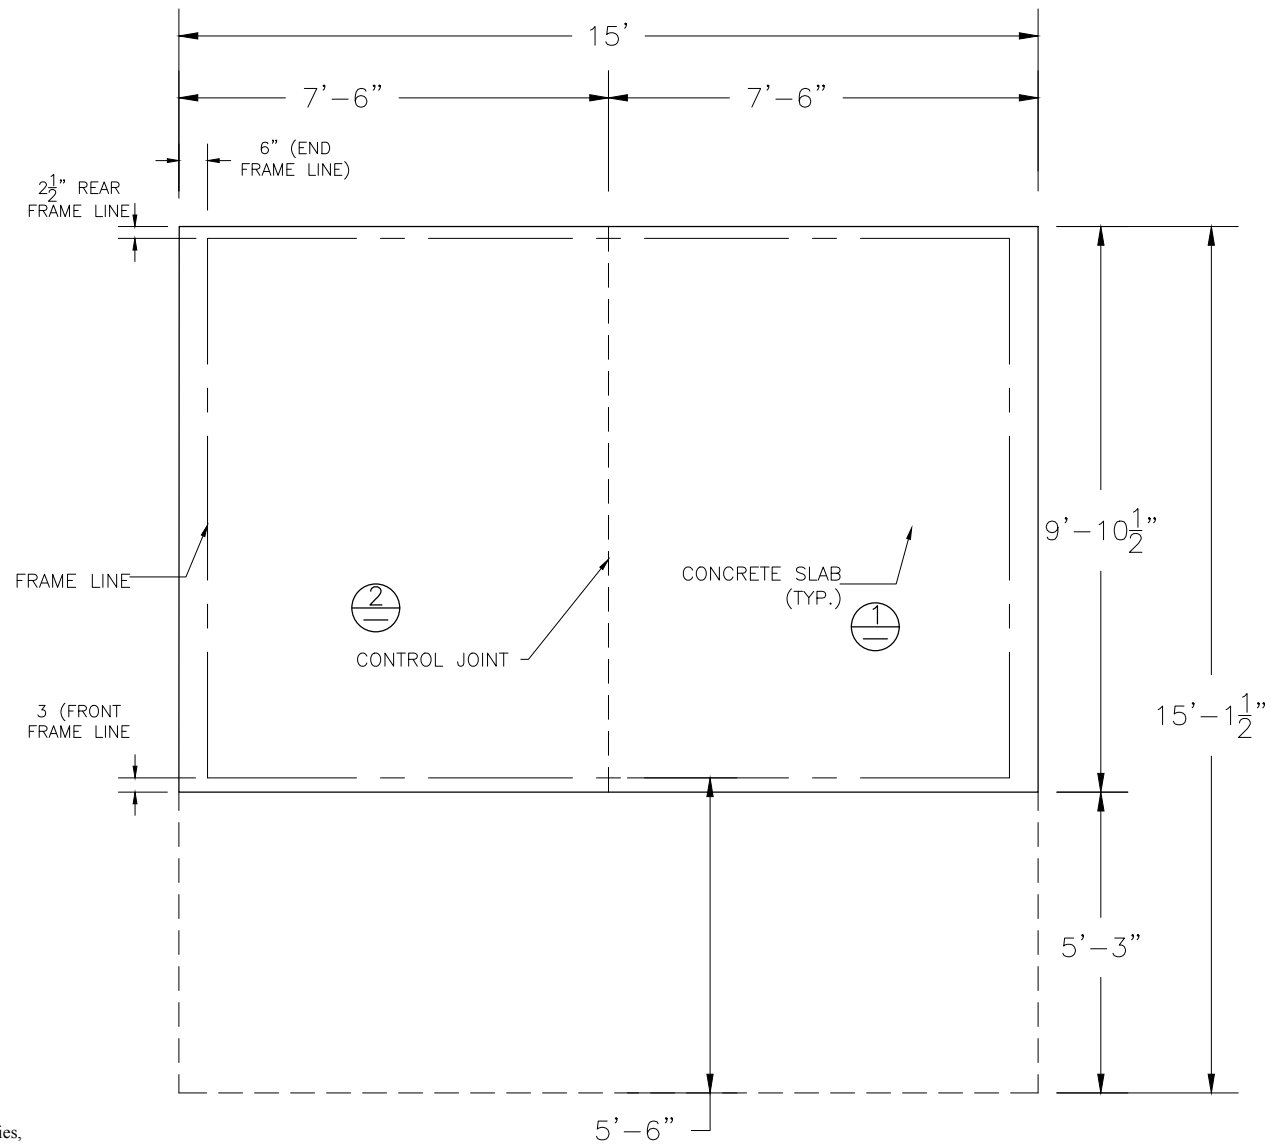

NOTE: CONCRETE PAD DOES NOT INCLUDE WHEELCHAIR EGRESS IN FRONT OF BLEACHER. ADD 5'-3" IN OVERALL DEPTH TO ACCOMMODATE WHEELCHAIRS.

CONCRETE FOUNDATION SPECIFICATIONS

SCOPE:
Foundation construction is not part of National Recreation Systems, Inc.'s (NRS) scope of work unless noted otherwise in the contract documents. The owner shall review the foundation design with the local code authorities, and coordinate with NRS.

FOUNDATION DESIGN & ANCHORS:


- 1) The foundation designs are based on the following:
 - a. Minimum presumed soil bearing 1000 psf.
 - b. Bleacher frame dead and live load 700 lbs./ft.
 - c. Bleacher frame wind uplift load 250 lbs./ft.
- 2) Unless otherwise noted on the drawings the bleacher frames shall be attached to the concrete with 3/8" dia. x 3" wedge type expansion anchors. The anchors shall be embedded a minimum of 2" into the concrete.

CONCRETE SPECIFICATIONS:

- 1) All concrete construction shall be in accordance with *ACI 318-08*.
- 2) All concrete shall have a minimum 28-day strength of $F_c=3000$ psi.
- 3) A 1/4" bituminous expansion joint material shall be placed between strip and slab foundations when adjacent to each other.
- 4) The depressions in the top of the foundations between high spots shall not exceed 5/16" below a 10-foot long straightedge. The 10-foot straightedge method used to measure foundation flatness shall be in accordance with Section of ACI 302.1R-04 "Guide for Concrete Floor and Slab Construction".

CONCRETE SLAB SPECIFICATIONS:

- 1) Concrete slab shall have a minimum thickness of 5" (NRS, Inc. recommends, and some areas may require 6" thickness) and placed on 4" of compacted gravel or compacted sand sub-base.
- 2) NRS, Inc. recommends that the concrete slab be reinforced with 6x6-W2.1xW2.1 welded wire fabric at 1 1/2" concrete cover from the top. In lieu of welded wire fabric, 2" XOREX by Ribbon Technology Corporation or equal corrugated steel fibers applied at a rate of 50-lbs./Cubic Yard may be used. Nylon or polypropylene fiber are not recommended.
- 3) Crack control joints shall be sawed into slab to form approximate square patterns. The maximum spacing for control joints shall not exceed 12'-6", unless shown otherwise on this drawing. The bleacher frames shall not be set on control joints. The designer shall contact NRS to coordinate joint spacing requirements with the specific bleacher design.
- 4) The slab may be sloped a maximum of 1/8 inch per foot for drainage. The maximum overall out of level slope for the slab perpendicular to the seats (front to rear) shall not exceed 2" and parallel to the seats (end to end) shall not exceed 4".

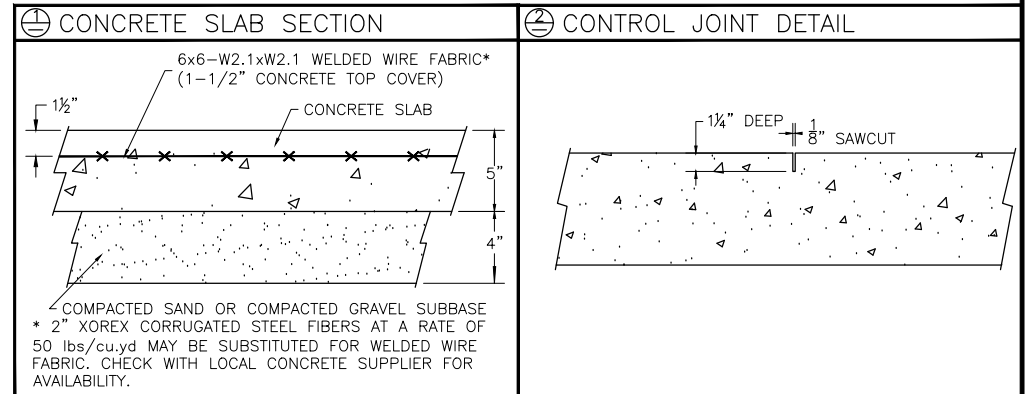


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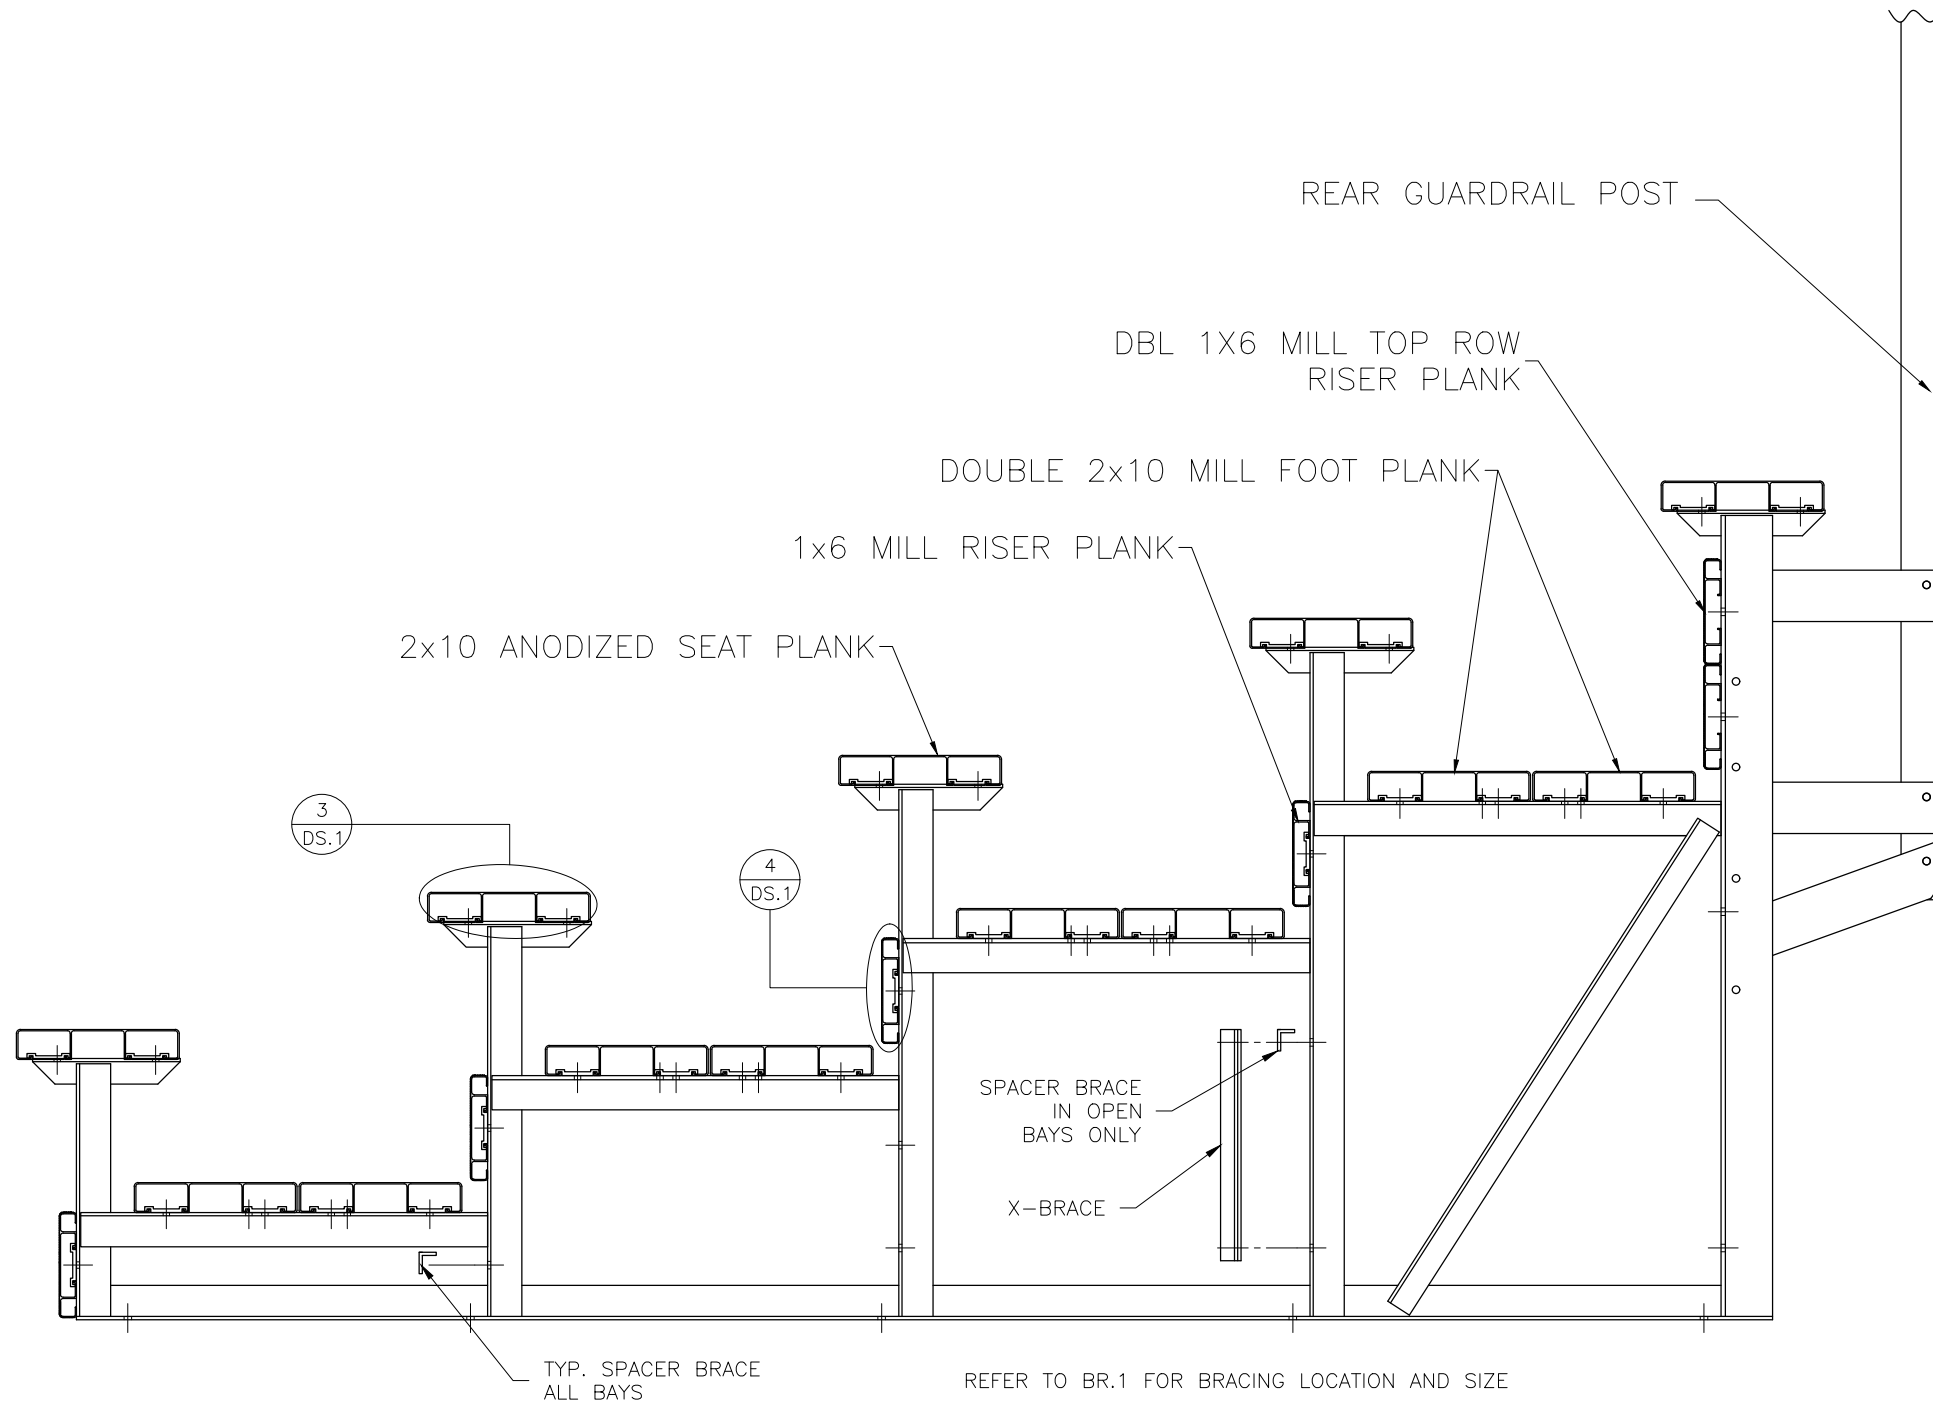
National Recreation Systems, Inc.

SCALE: N.T.S.	APPROVED BY: CHUCK	DRAWN BY: JML
DATE: 10/02/2015	5/20/2016	
TITLE: NON ELEVATED 5 ROW x 15'-0" FOUNDATION PLAN		
CUSTOMER: NA-0515DLX_CLL	DRAWING NUMBER:	REV. DATE: FP.1

DETAIL "A" - CONCRETE ANCHOR ATTACHMENT

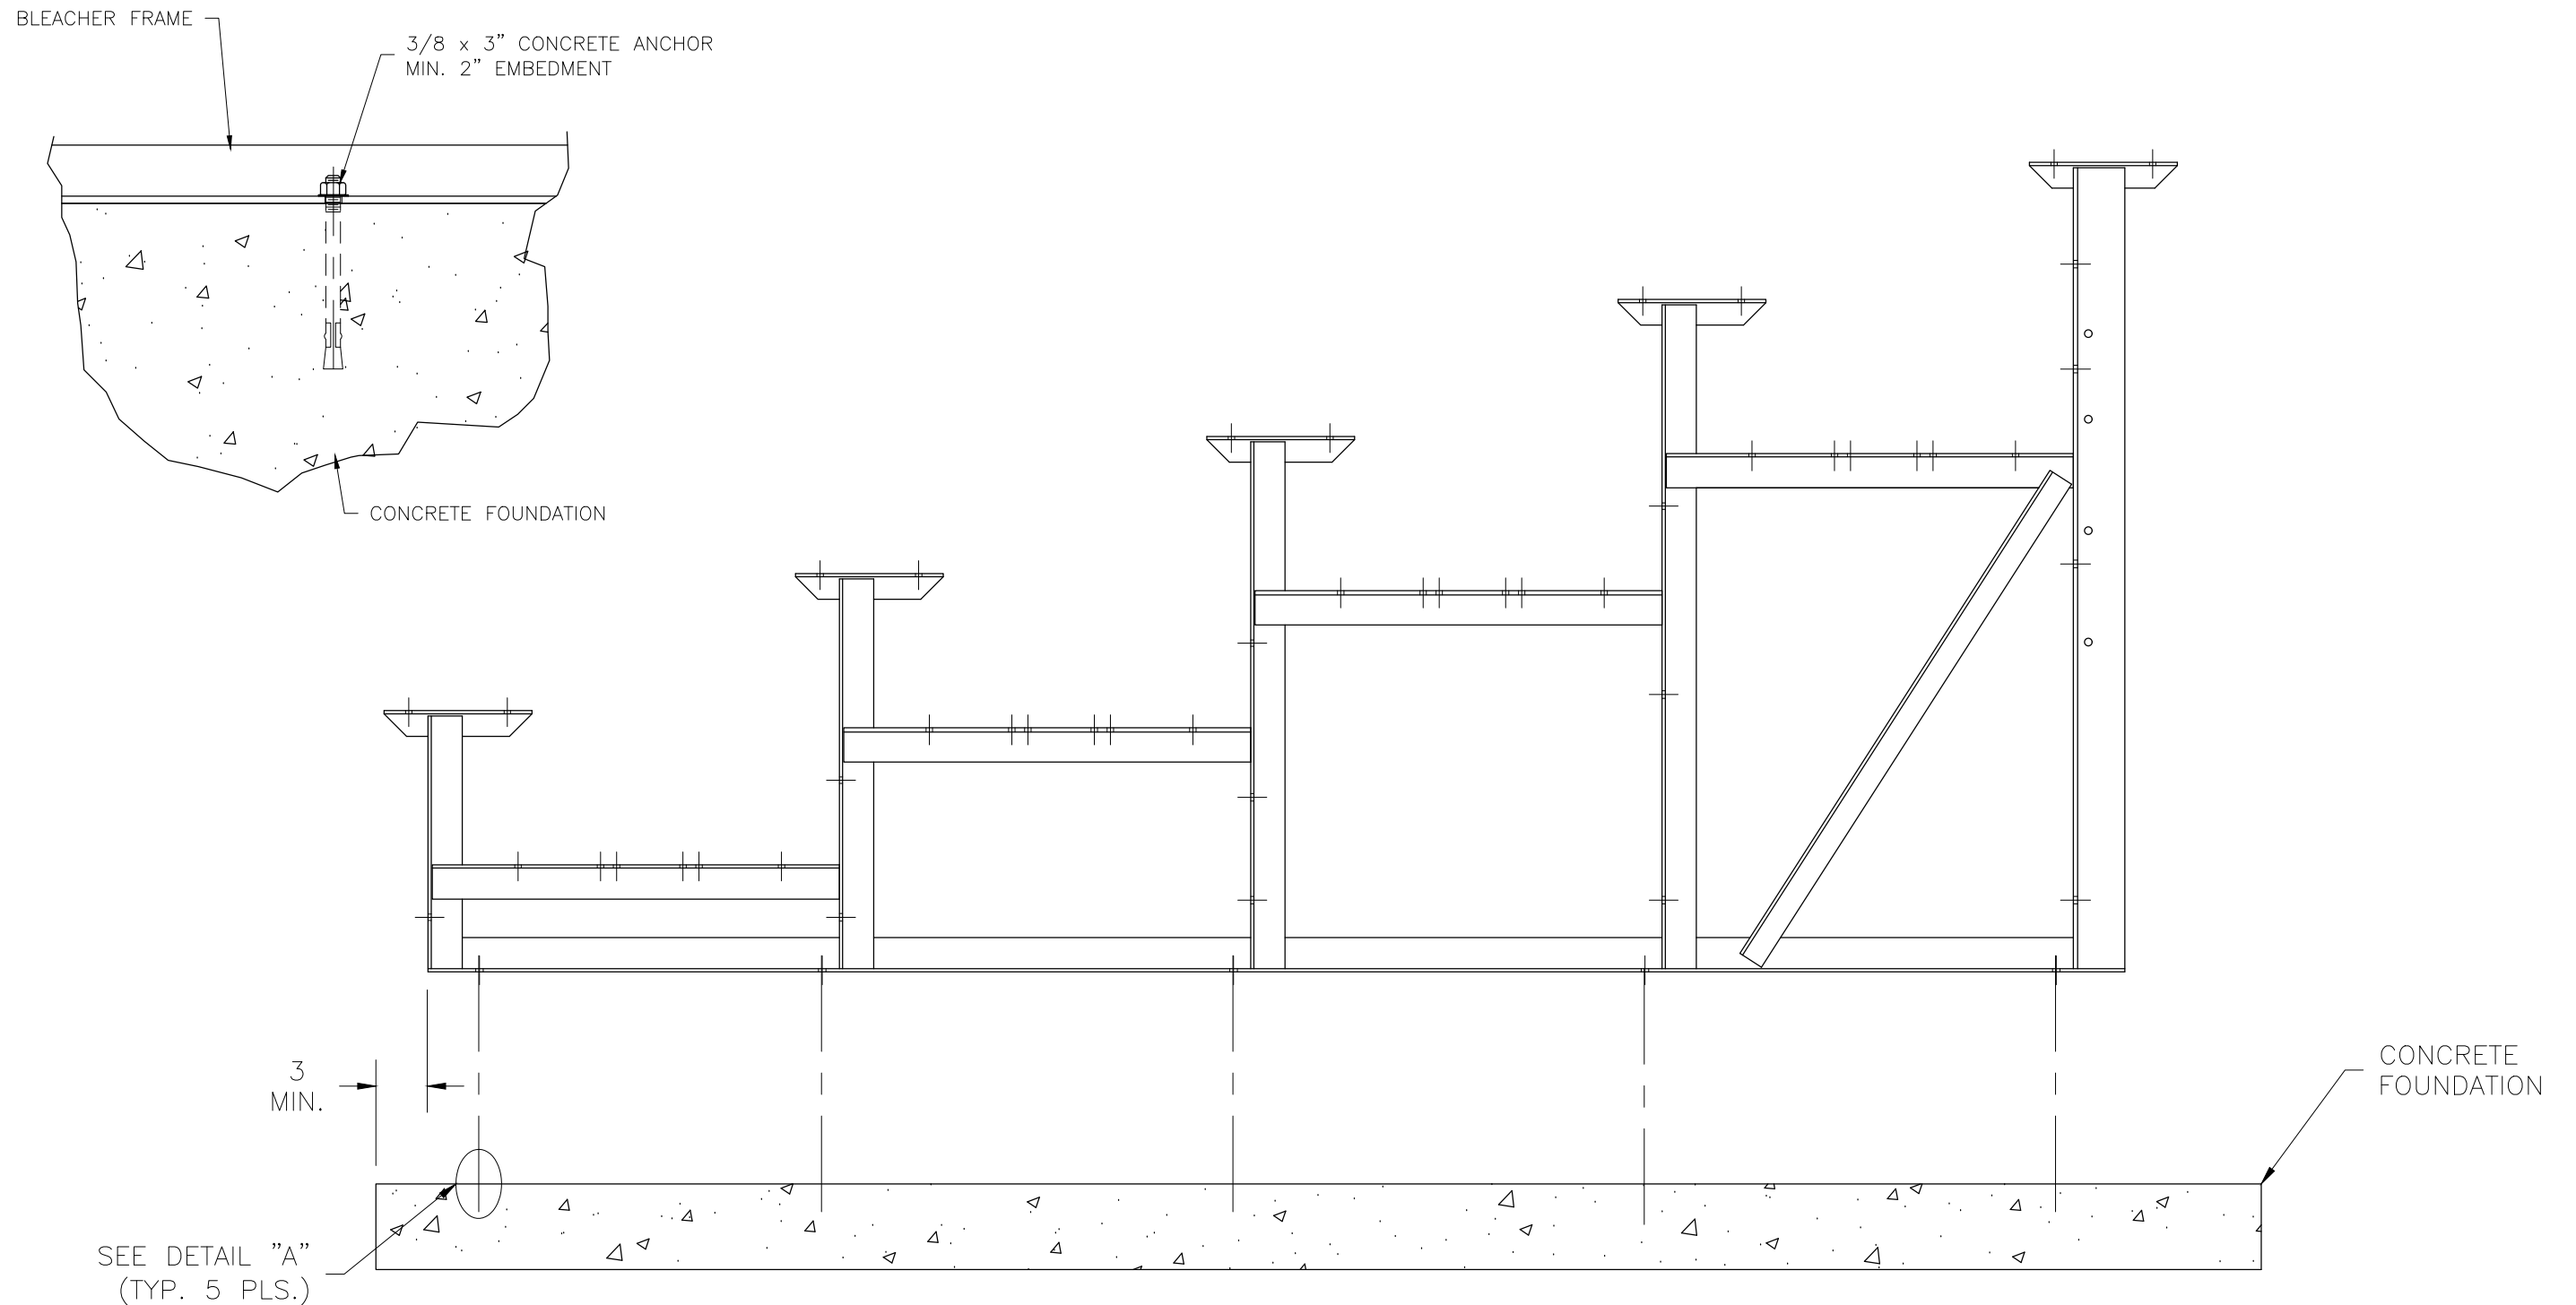


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DATE: 10/02/2015		5/20/2016			
TITLE: NON ELEVATED 5 ROW x 15'-0" ANCHORING PLAN					
CUSTOMER: NA-0515DLX_CLL		DRAWING NUMBER:		REV. DATE: AP.1	



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				SCALE: N.T.S.	APPROVED BY: CHUCK
DATE: 10/02/2015		5/20/2016			
TITLE: NON ELEVATED 5 ROW x 15'-0" BLEACHER ASSEMBLY					
CUSTOMER: NA-0515DLX_CLL		DRAWING NUMBER:		REV. DATE: BA.1	


PRE-ASSEMBLE X-BRACE SETS. EACH SET CONSISTS OF ONE FLAT BAR AND ONE ANGLE. ONCE ASSEMBLED, THEY WILL BECOME AN "X". THEY BOLT TOGETHER WITH A $\frac{3}{8}$ " X $1\frac{1}{4}$ " HEX HEAD BOLT AND FLANGE NUT THRU THE CENTER HOLE. (SEE DETAIL 24 ON DETAIL SHEET)

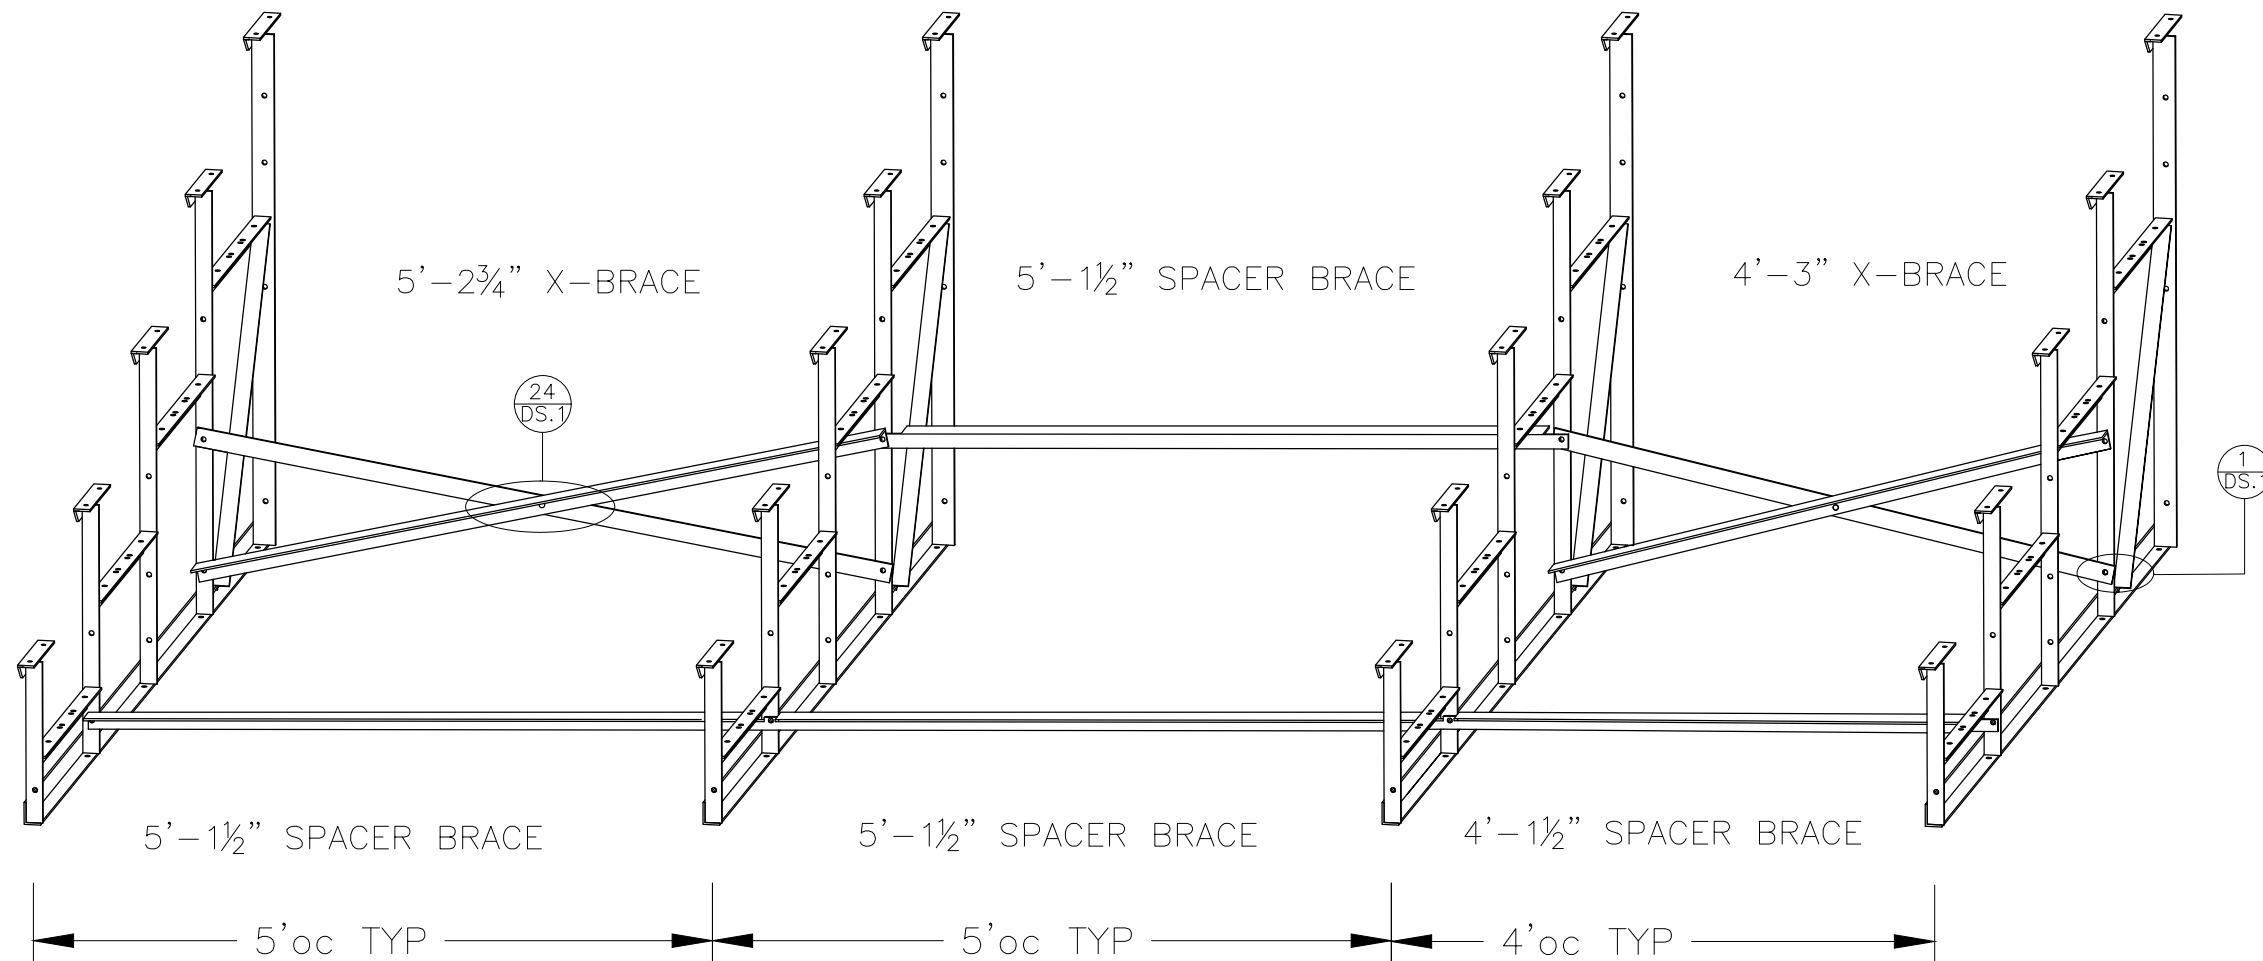


DETAIL IS TO DEPICT CROSS BRACING ATTACHMENT ONLY. FRAME DESIGN MAY VARY.

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SCALE:	N.T.S.	APPROVED BY:	CHUCK 5/20/2016		DRAWN BY:	JML
DATE:	11/13/14					
TITLE:	NON ELEVATED 5 ROW x 15'-0" BRACE ASSEMBLY					
CUSTOMER:	NA-0515DLX_CLL	DRAWING NUMBER:			REV. DATE:	BR.1

PLANK PLAN

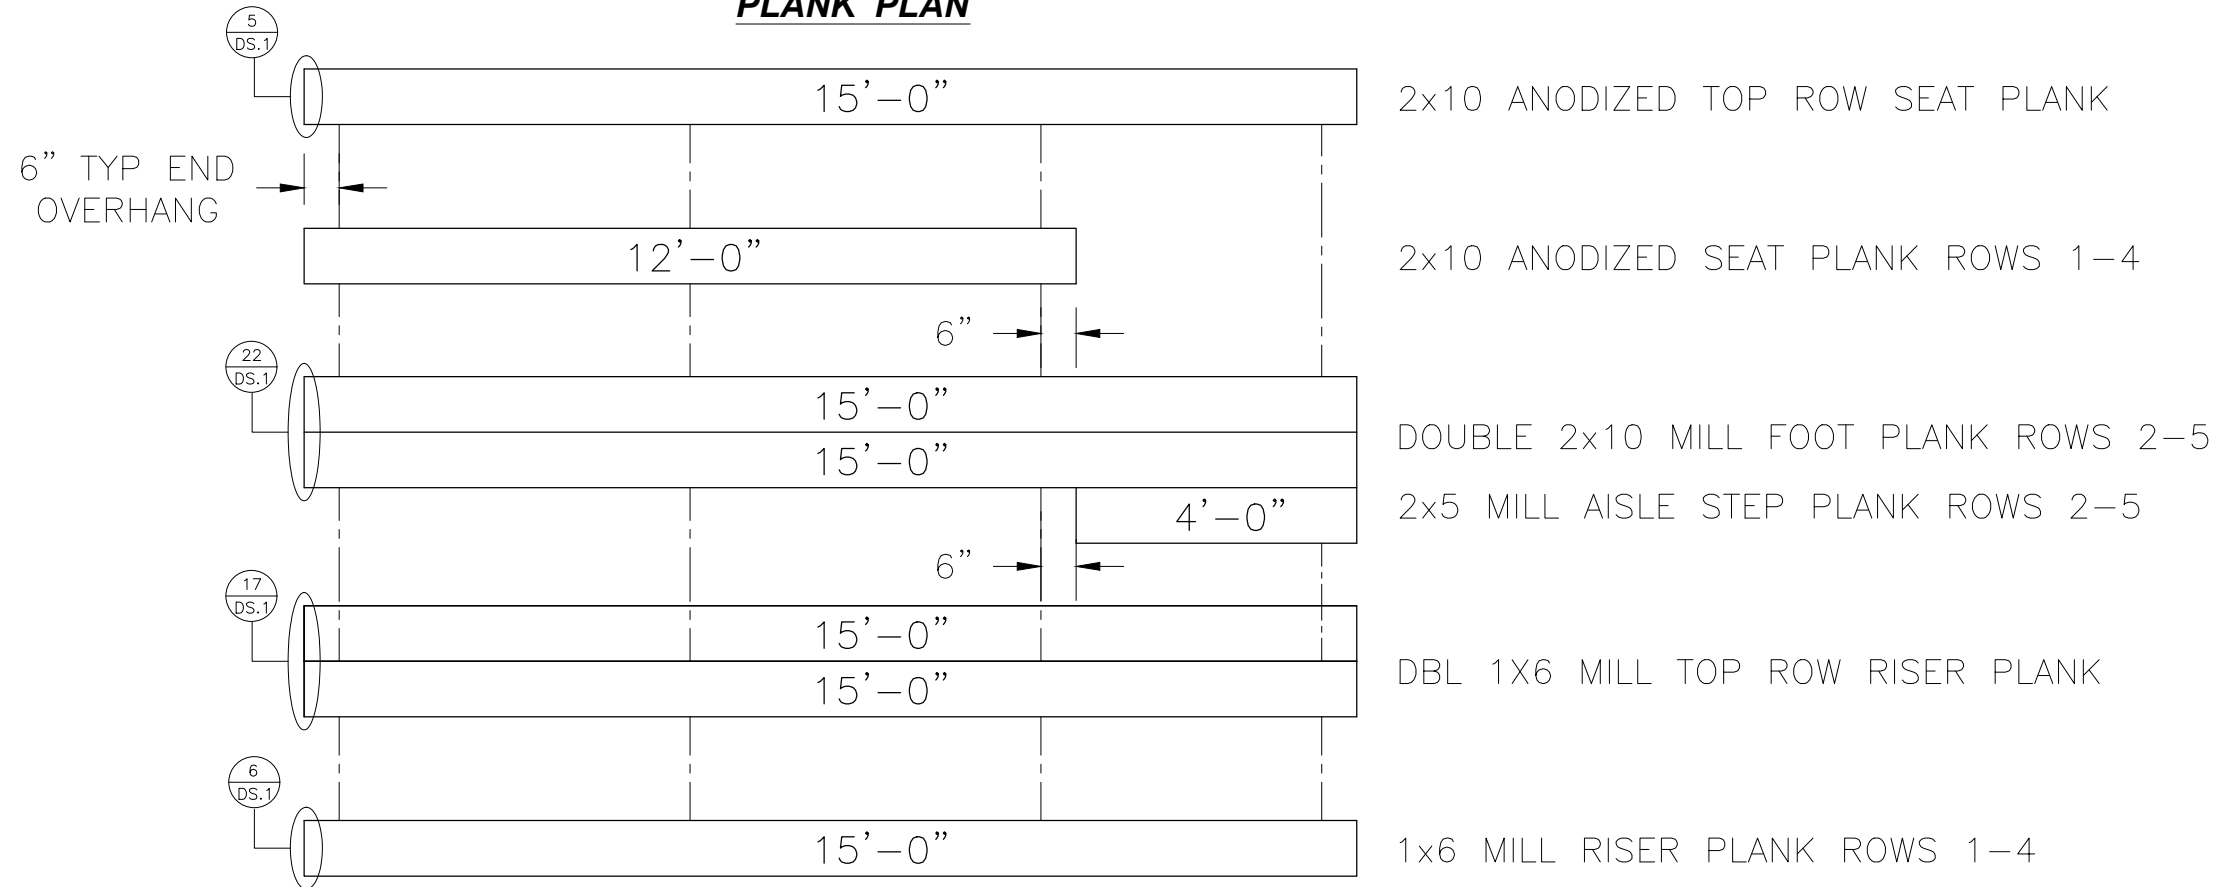


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			SCALE: N.T.S.	APPROVED BY:
			DATE: 10/02/2015	
TITLE: NON ELEVATED 5 ROW x 15'-0" PLANK & FRAMING PLAN				
CUSTOMER: NA-0515DLX_CLL		DRAWING NUMBER:	REV. DATE:	PF.1


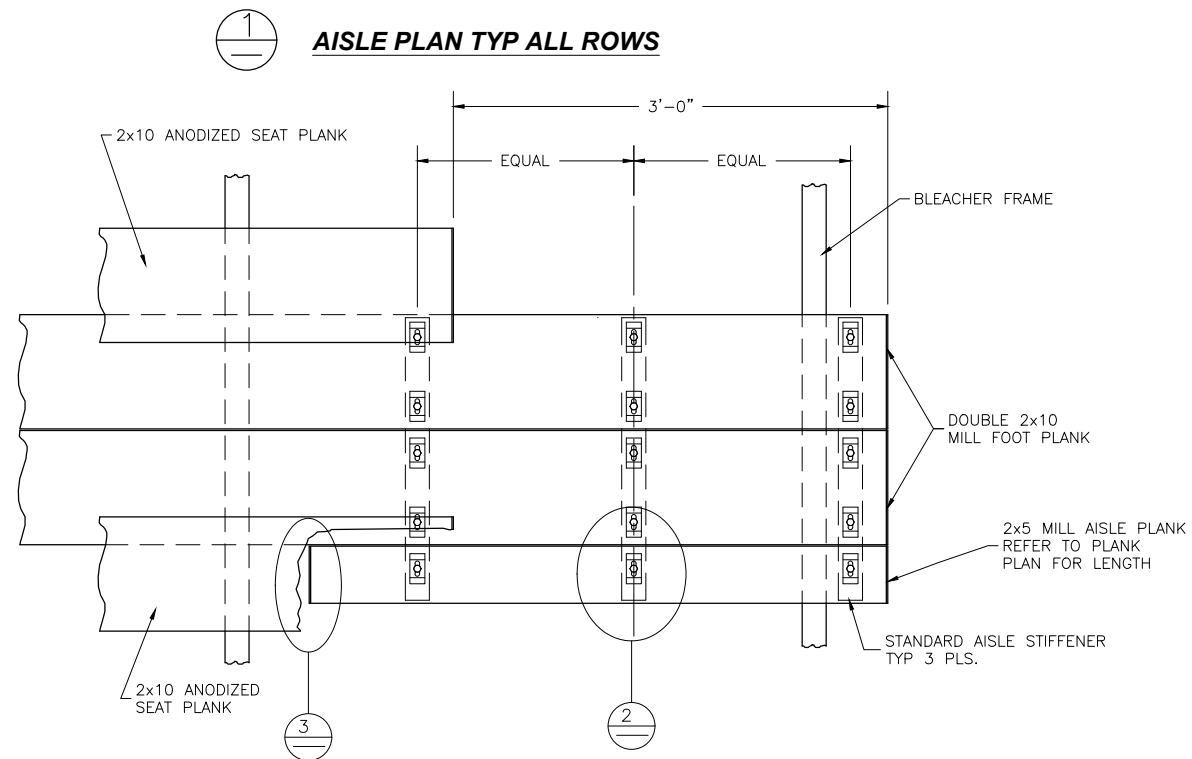


**AISLE AS SHOWN
OR OPPOSITE HAND**

⊕ TYP. AISLE BKT DETAIL

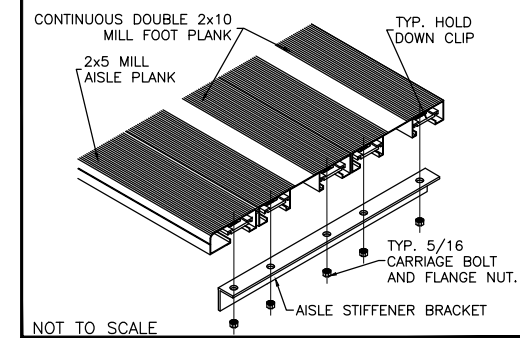

⊕ TYP 2x5 ENDCAP ATTACHMENT

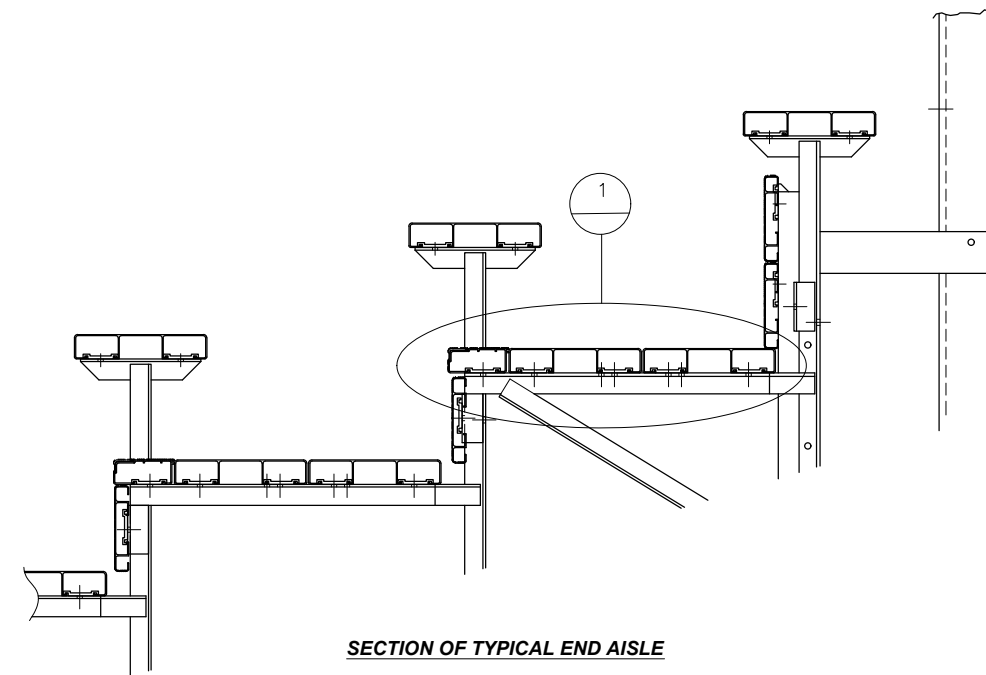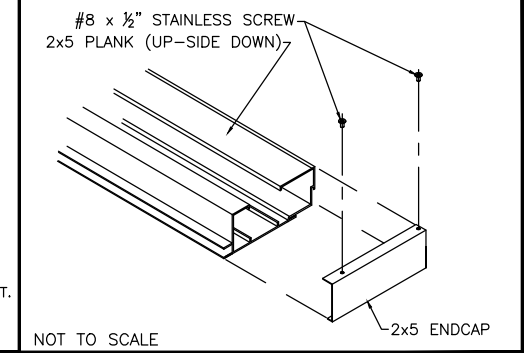

SECTION OF TYPICAL END AISLE






SEE APPROPRIATE GUARDRAIL ASSEMBLY
PRINT FOR AISLE HANDRAIL ASSEMBLY.

ALIGN EDGE OF FLANGE APPROX. 1/2" FROM THE LEADING EDGE OF THE FRONTMOST CONTINUOUS 2x10 FOOT PLANK (NOT THE 2x5 AISLE STEP PLANK). SLIGHTLY ADJUST FLANGE LOCATION, IF NECESSARY, SO THAT THE BOLT HOLE IS NOT DRILLED INTO A VERTICAL LEG OF THE PLANK. DRILL $\phi 7/16$ " HOLES (FOR 3/8" BOLT). ASSEMBLE AS SHOWN USING BOLTS, & FLANGE NUTS.

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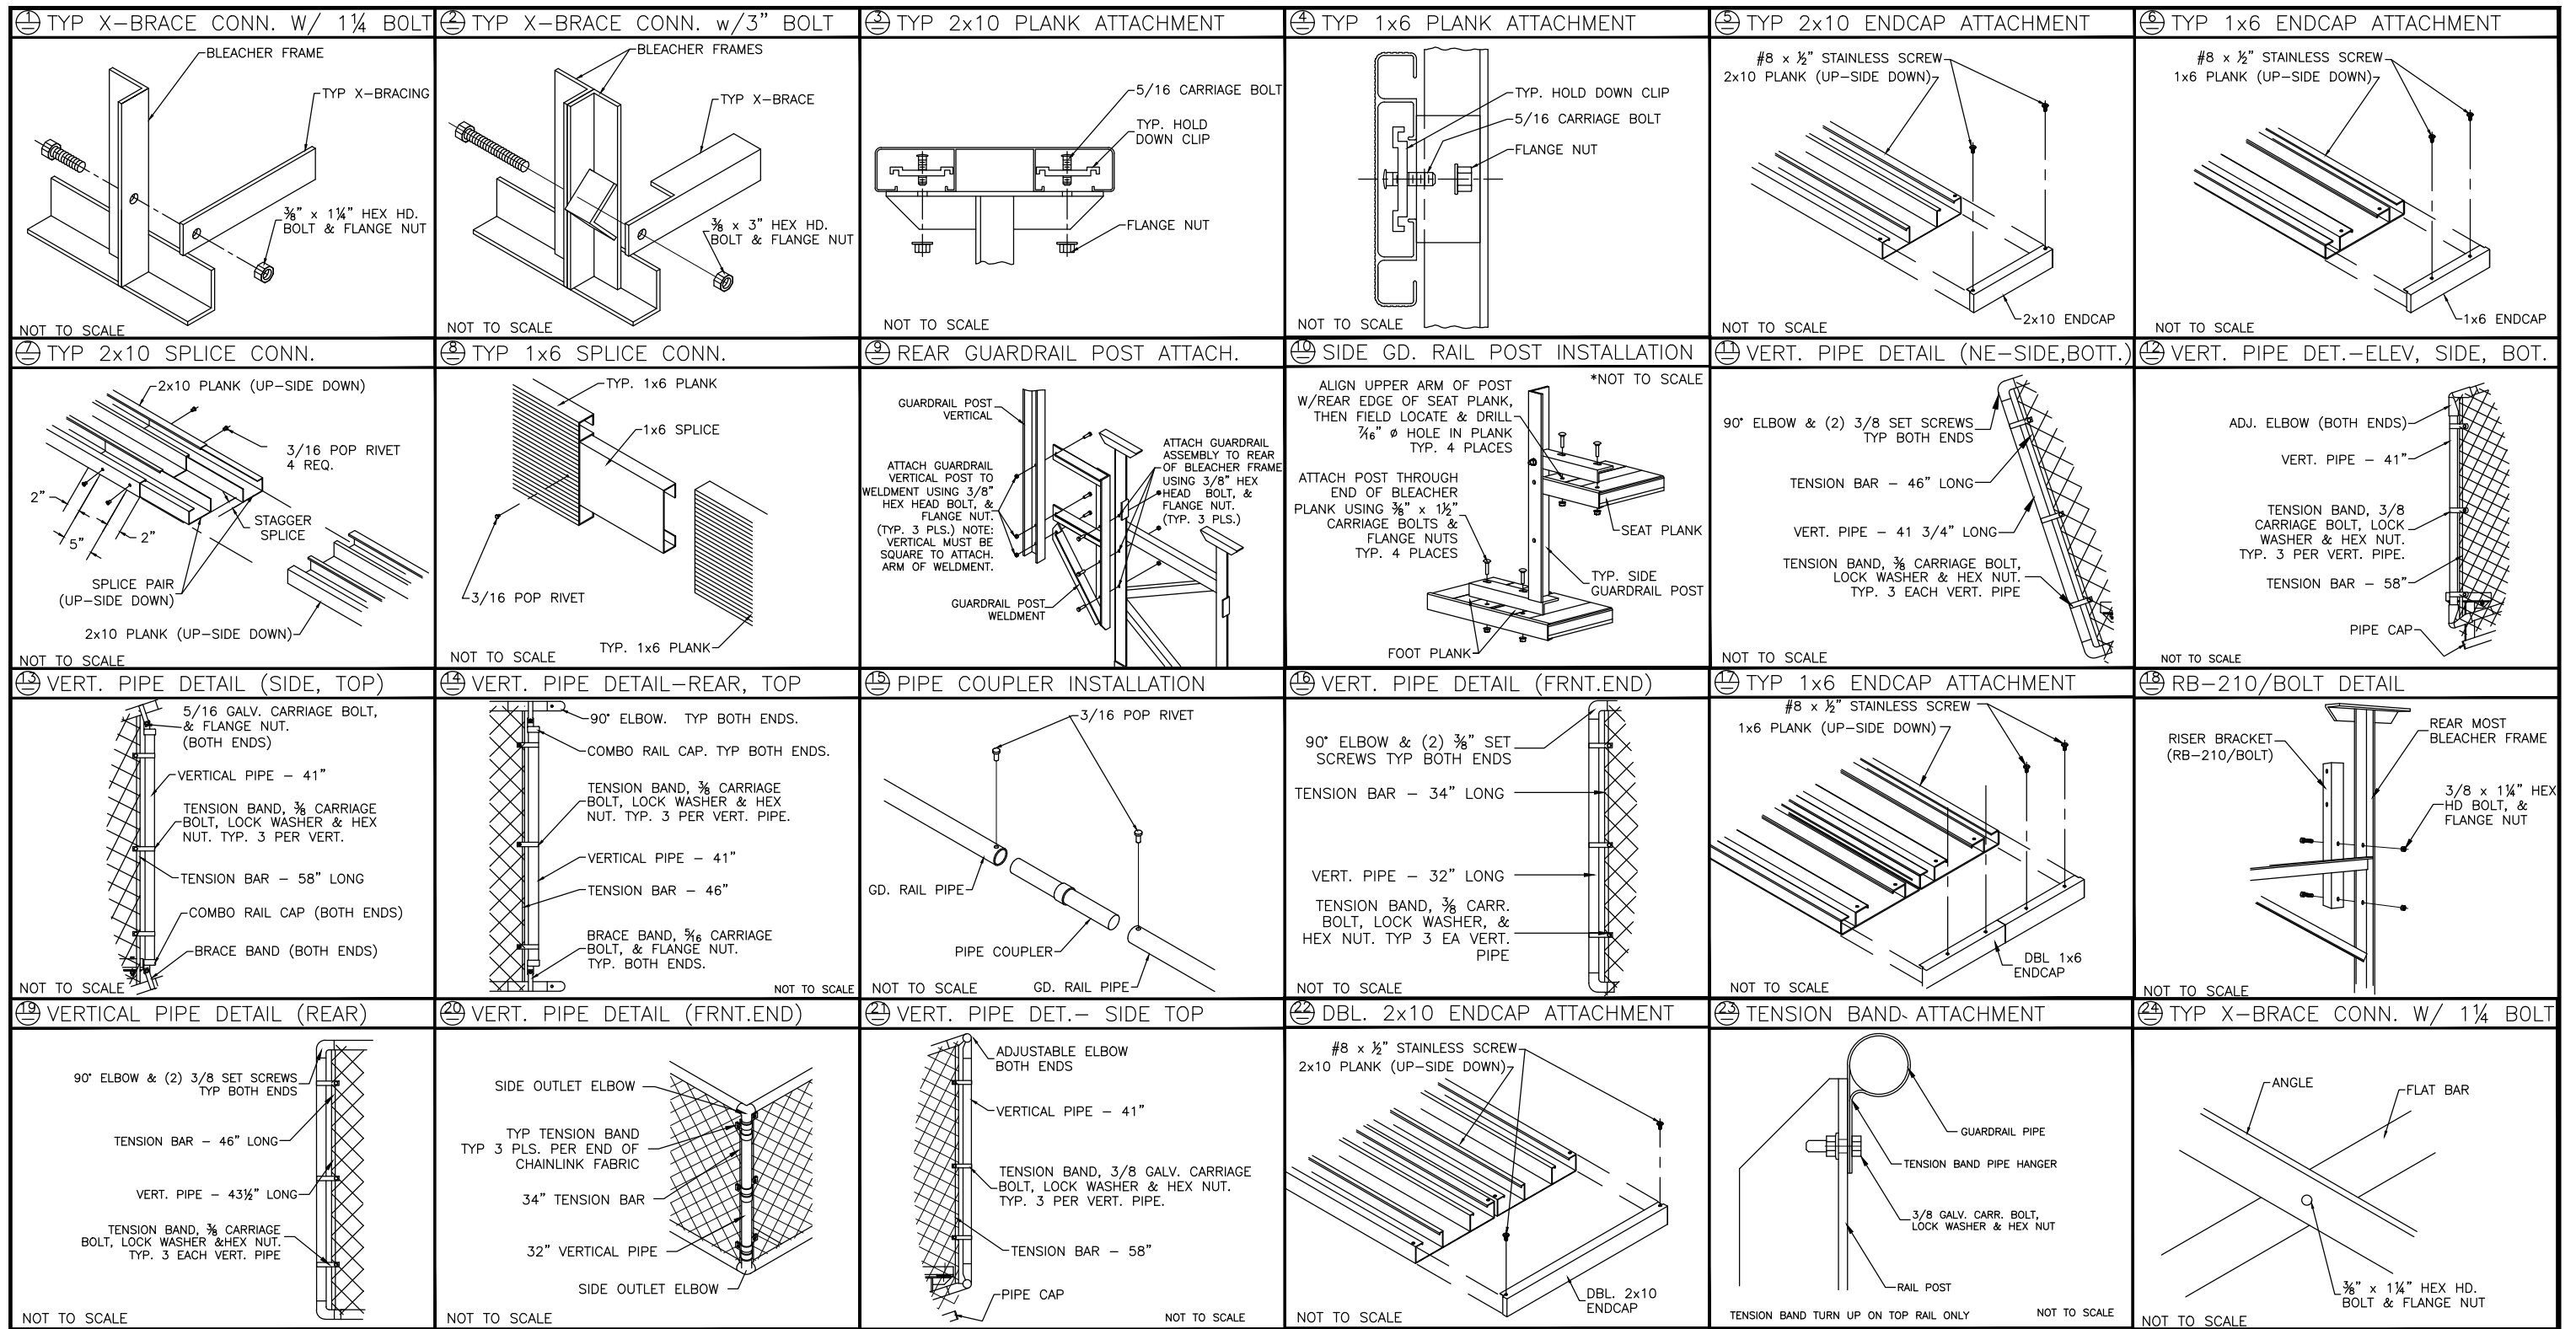
SCALE: N.T.S.	APPROVED BY: CHUCK 5/20/2016	DRAWN BY: JML
DATE: 10/02/2015	TITLE: NON ELEVATED 5 ROW x 15'-0" PLANK & FRAMING PLAN	
CUSTOMER: NA-0515DLX CLL	DRAWING NUMBER:	REV. DATE: VA.1



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SCALE: N.T.S.	APPROVED BY: CHUCK	DRAWN BY: JML
DATE: 10/02/2015	5/20/2016	
TITLE: NON ELEVATED 5 ROW x 15'-0" GUARD RAIL ASSEMBLY		
CUSTOMER: NA-0515DLX_CLL	DRAWING NUMBER:	REV. DATE: GR.1

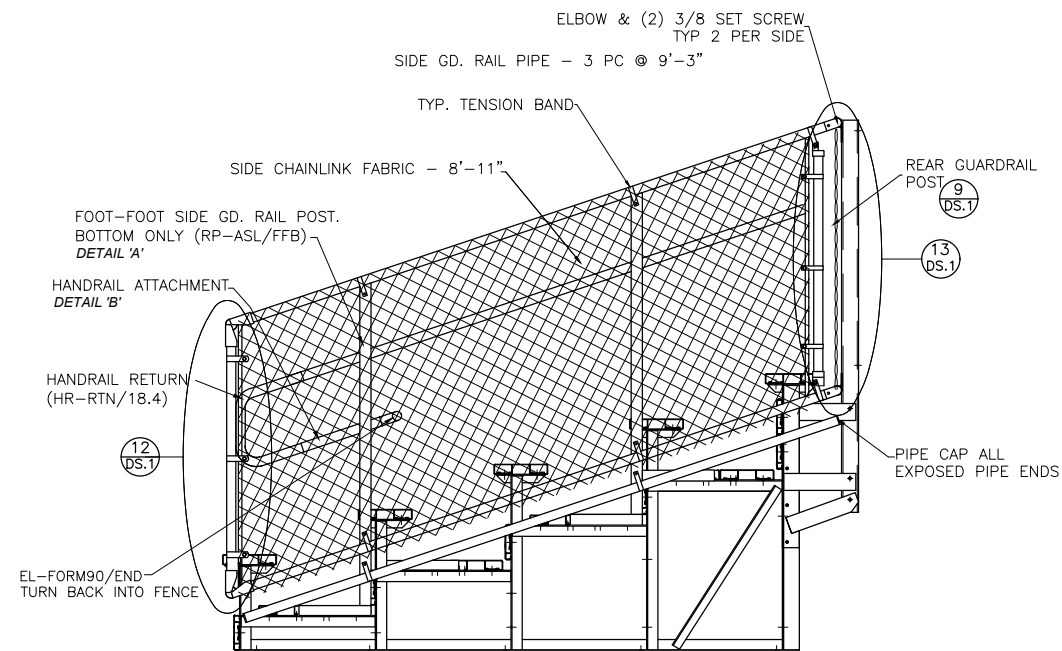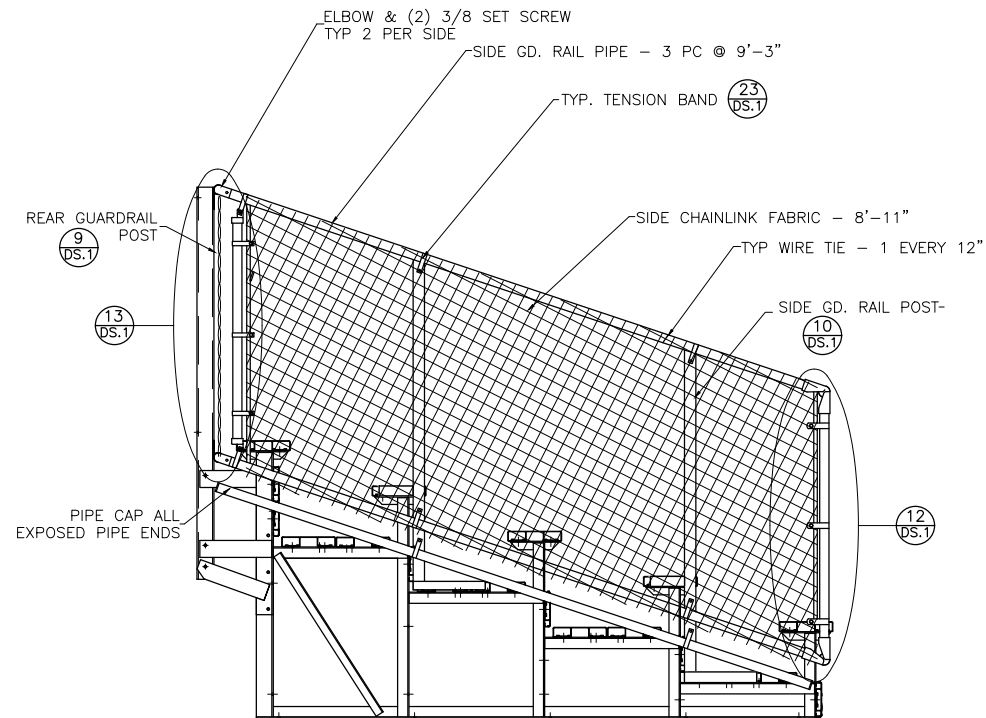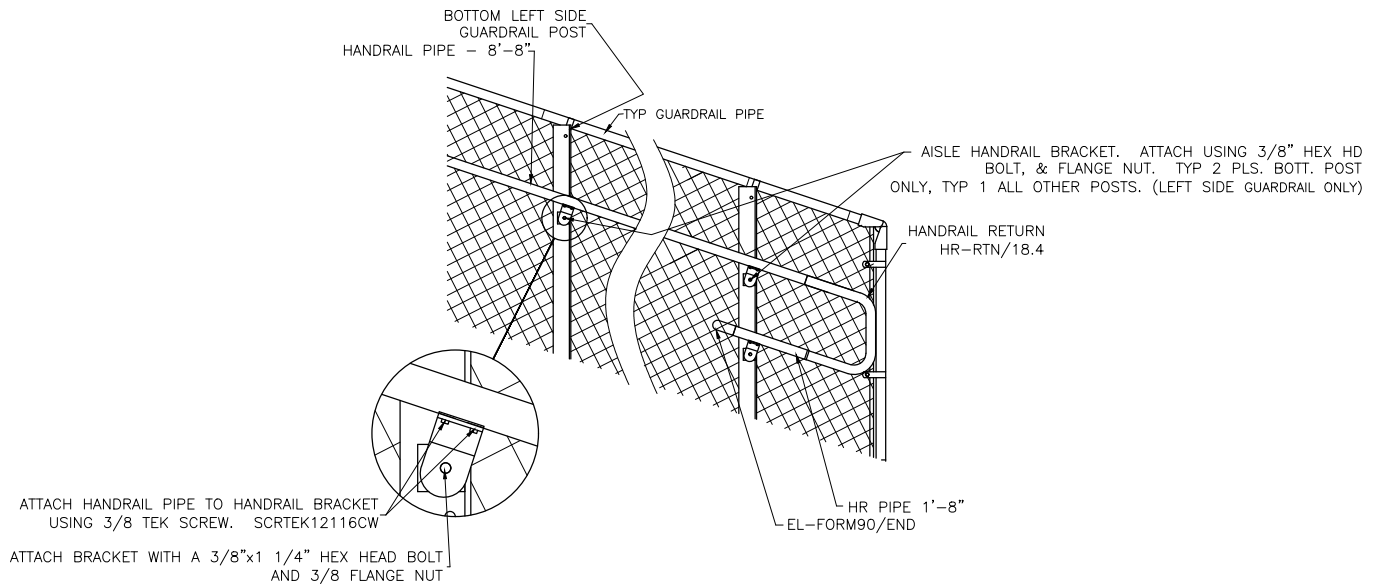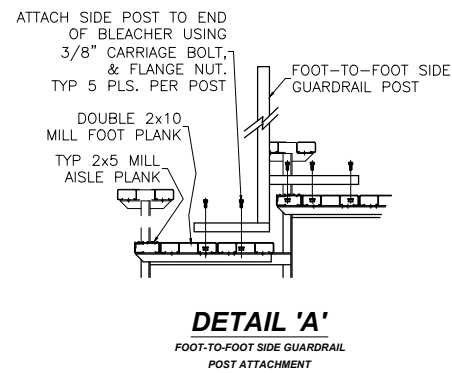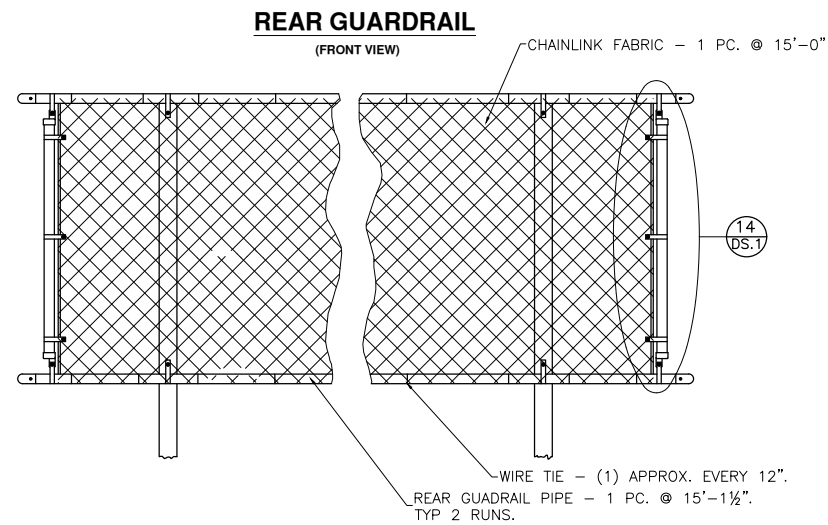

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SCALE: N.T.S.	APPROVED BY: CHUCK 5/20/2016	DRAWN BY: JML
DATE: 10/02/2015	TITLE: DETAIL SHEETS	
CUSTOMER: NA-0515DLX_CLL	DRAWING NUMBER:	REV. DATE: DS.1